


CONTRACTING, L EMERALD RALT,


GIBI © VM PESIGN &
ASSOCIATES, NC.
426 SW COMMERCE DR, STE 130
LAKE CITY, FL 32025
(386) 758-8406
will@willmyers.net

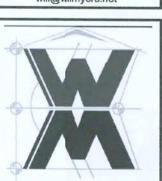

JOB NUMBER 20191026


SHEETNUMBER

A.1 OF 3SHEETS

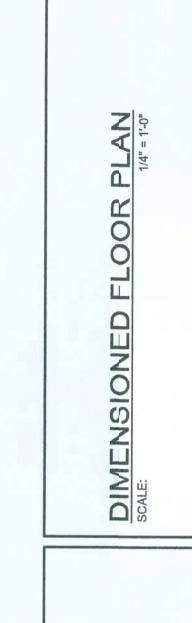

CONTRACTING EMERALD GIBRALTAR

© VM DESIGN &
ASSOCIATES, INC.
426 SW COMMERCE DR, STE 130
LAKE CIT', FL 32025
(386) 758-8406
will@wilmyers.net

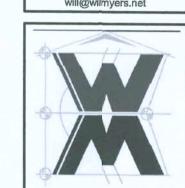

AREA SUMMARY

1,880 S.F.

503 S.F.

124 S.F.

2,557 S.F.

50 S.F.

LIVING AREA

**GARAGE AREA** 

TOTAL AREA


**ENTRY PORCH AREA** 

COVERED PORCH AREA

JOB NUMBER 20191026

SHEET NUMBER

OF 3 \$HEETS

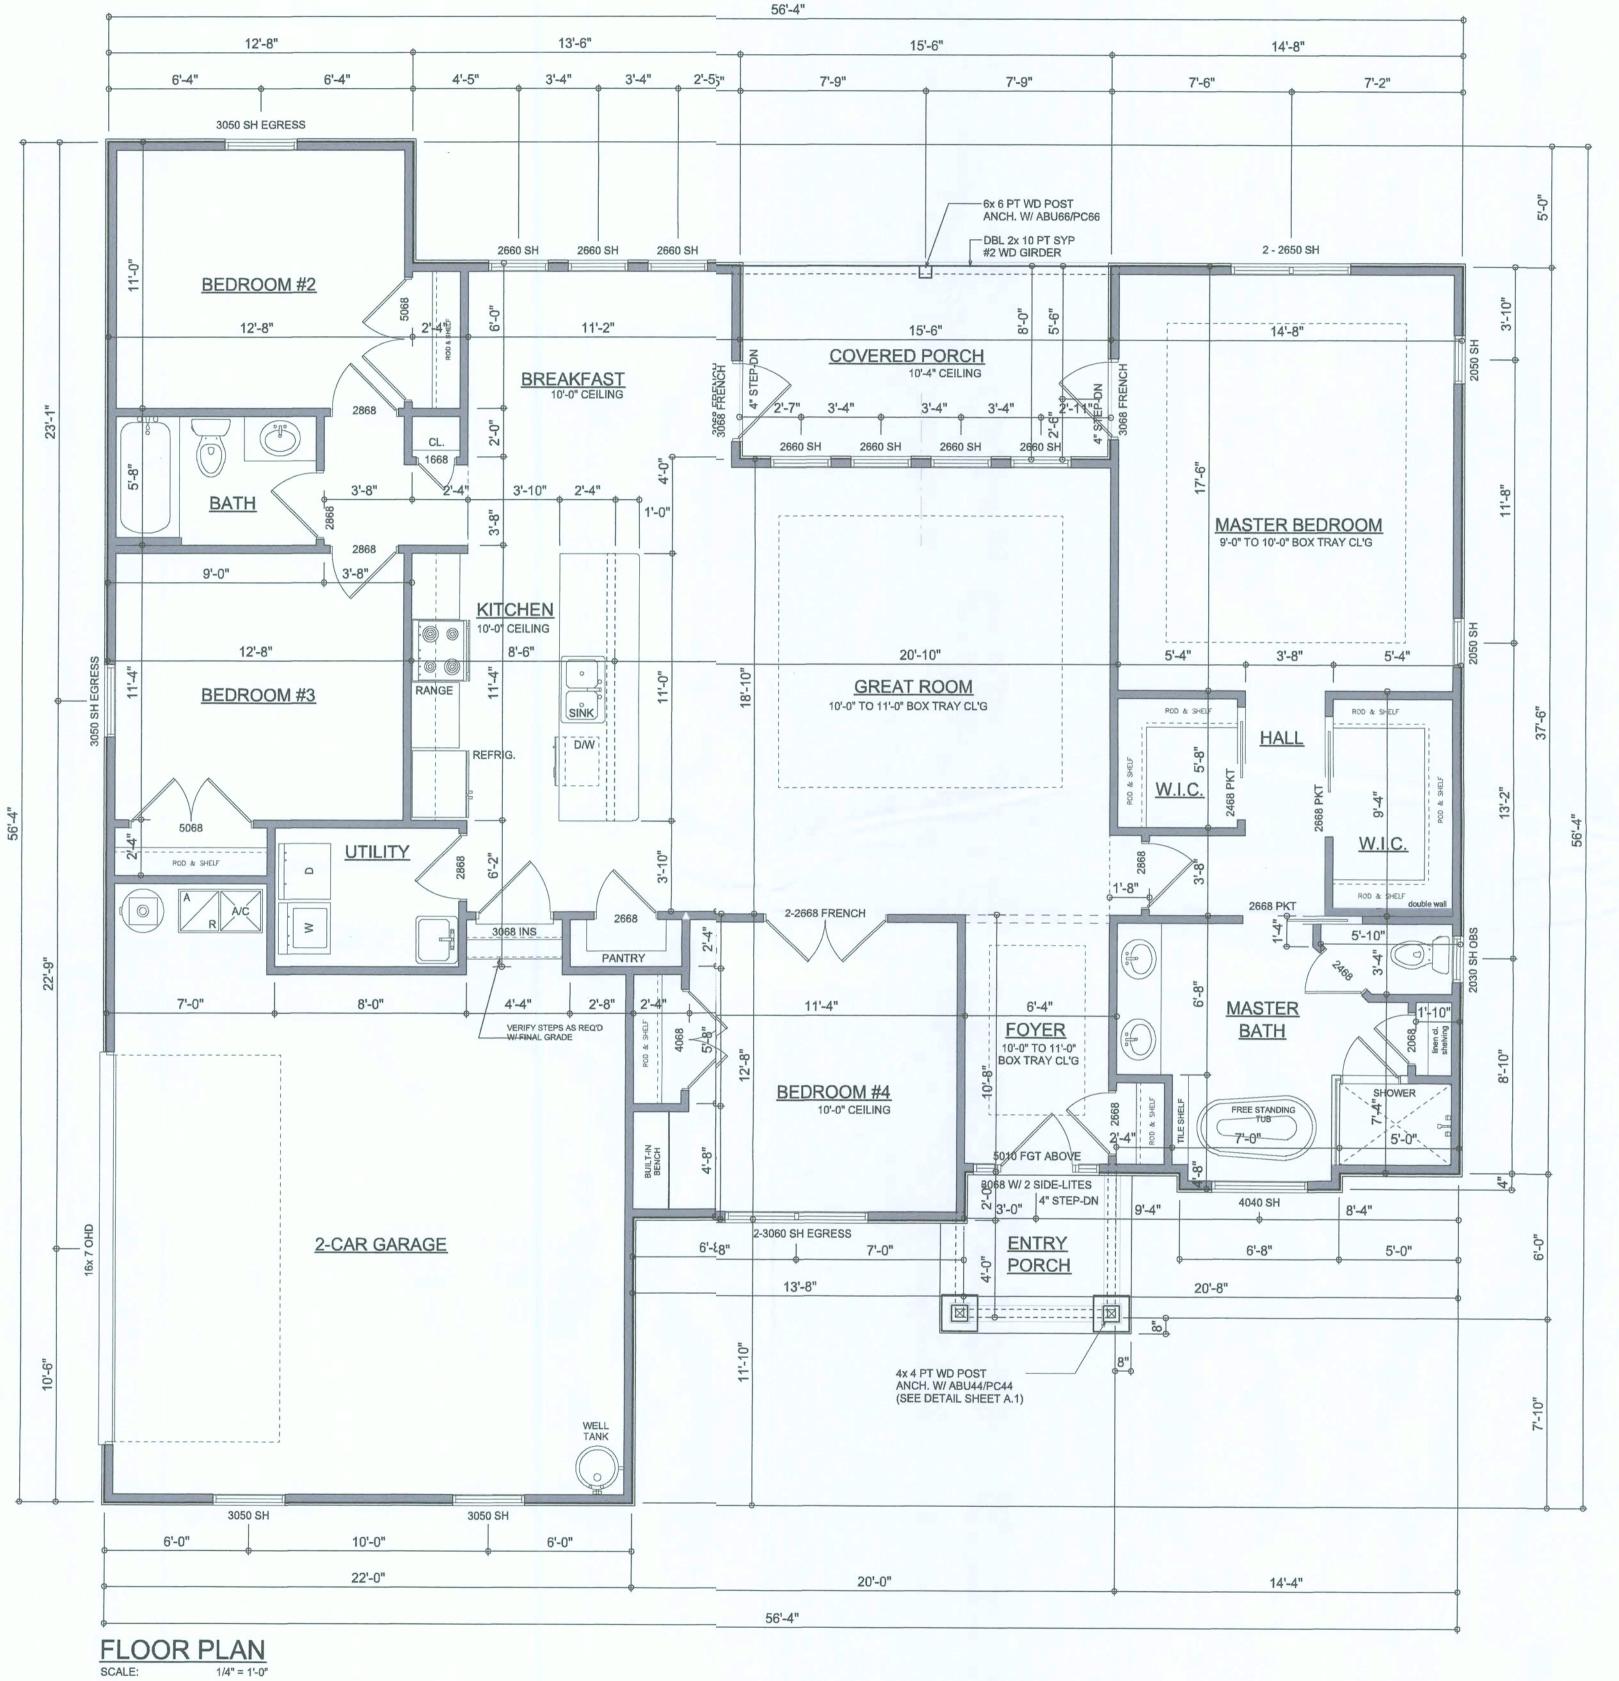


ALL CEILINGS SHALL BE 9'-0" UNLESS OTHERWISE NOTED

AN = 1.0"

CONTRACTING EMER GIBRALTAR
LIC# 1259633 HIGH SP

© WMDESIGN &
ASSOCIATES, NC.
426 SW COMMERCE DR, STE 130
LAKE CITY, FL 32025 (386)758-8406 will@villmyers.net

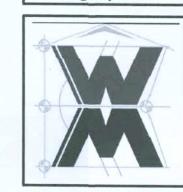

JOB NUMBER 20191026

SHEET NUMBER

OF 3 SHEETS


ELECTRICAL LEGEND CEILING FAN (PRE-WIRE FOR LIGHT KIT) DOUBLE SECURITY RECESSED CAN LIGHT BATH EXHAUST FAN LIGHT FIXTURE DUPLEX OUTLET (AFCI & TAMPER RESISTANT) 220v OUTLET GFI DUPLEX OUTLET (PER NEC 406.8) TELEVISION JACK TELEPHONE JACK SMOKE / CARBON MONOXIDE DETECTOR (see note below) WALL SWITCH 3 WAY WALL SWITCH 48" FLOUR. 2 OR 4 TUB FLUORESCENT FIXTURE


NOTE: ALL INTERIOR RECEPTACLES SHALL BE AFCI (ARC FAULT CIRCUIT NTERRUPT) PER NEC 210.12 & TAMPER RESISTANT PER NEC 406.11


ALL SMOKE DETECTORS BE A COMBO SMOKE & CARBON MONOXIDE DETECTOR AND SHALL HAVE BATTERY BACKUP POWER AND ALL WIRED TOGETHER SO IF ANY ONE UNIT IS ACTUATED THEY ALL ACTIVATE.

THE ELECTRICAL SERVICE OVERCURRENT PROTECTION DEVICE SHALL BE INSTALLED ON THE EITERIOR OF STRUCTURES TO SERVE AS A DISCONNECT MEANS. CONDUCTORS USED ROM THE EXTERIOR DISCONNECTING MEANS TO A PANEL OR SUB PANEL SHALL HAVE FOUR-WIRE CONDUCTORS, OF WHICH ONE CONDUCTOR SHALL BE USED AS AI EQUIPMENT GROUND.

IT IS THE LICENSED EECTRICAL CONTRACTORS RESPONSIBILITY TO INSURE THAT ALL WORK PERFORMED AND EQUIPMENT INSTALLED MEETS OR EXCEEDS THE NFPA70 2014 NATIONAL ELECTRIC CODE ANDALL OTHER LOCAL CODES AND ORDINANCES.

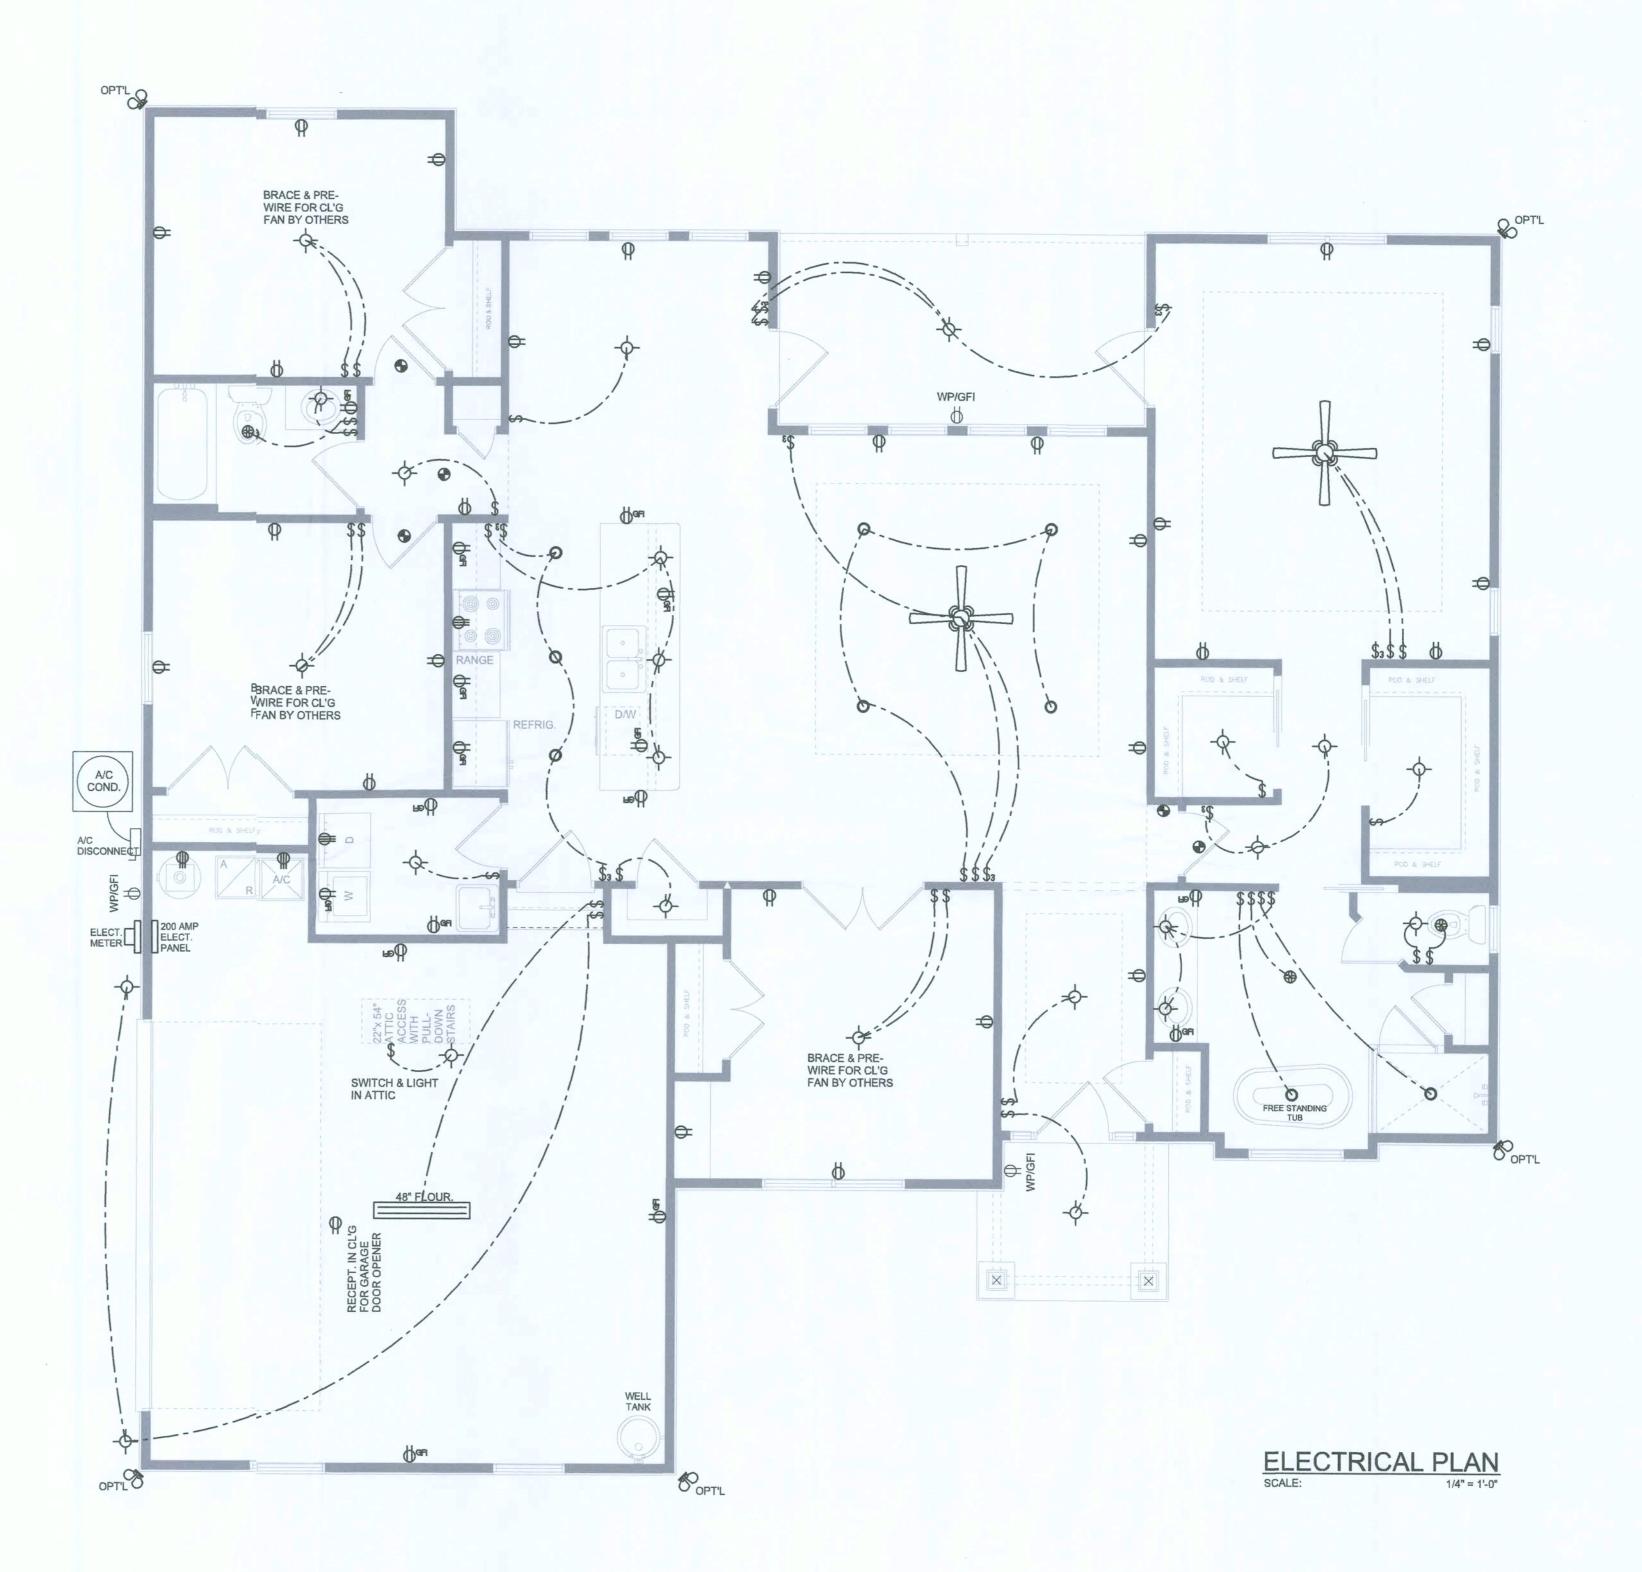


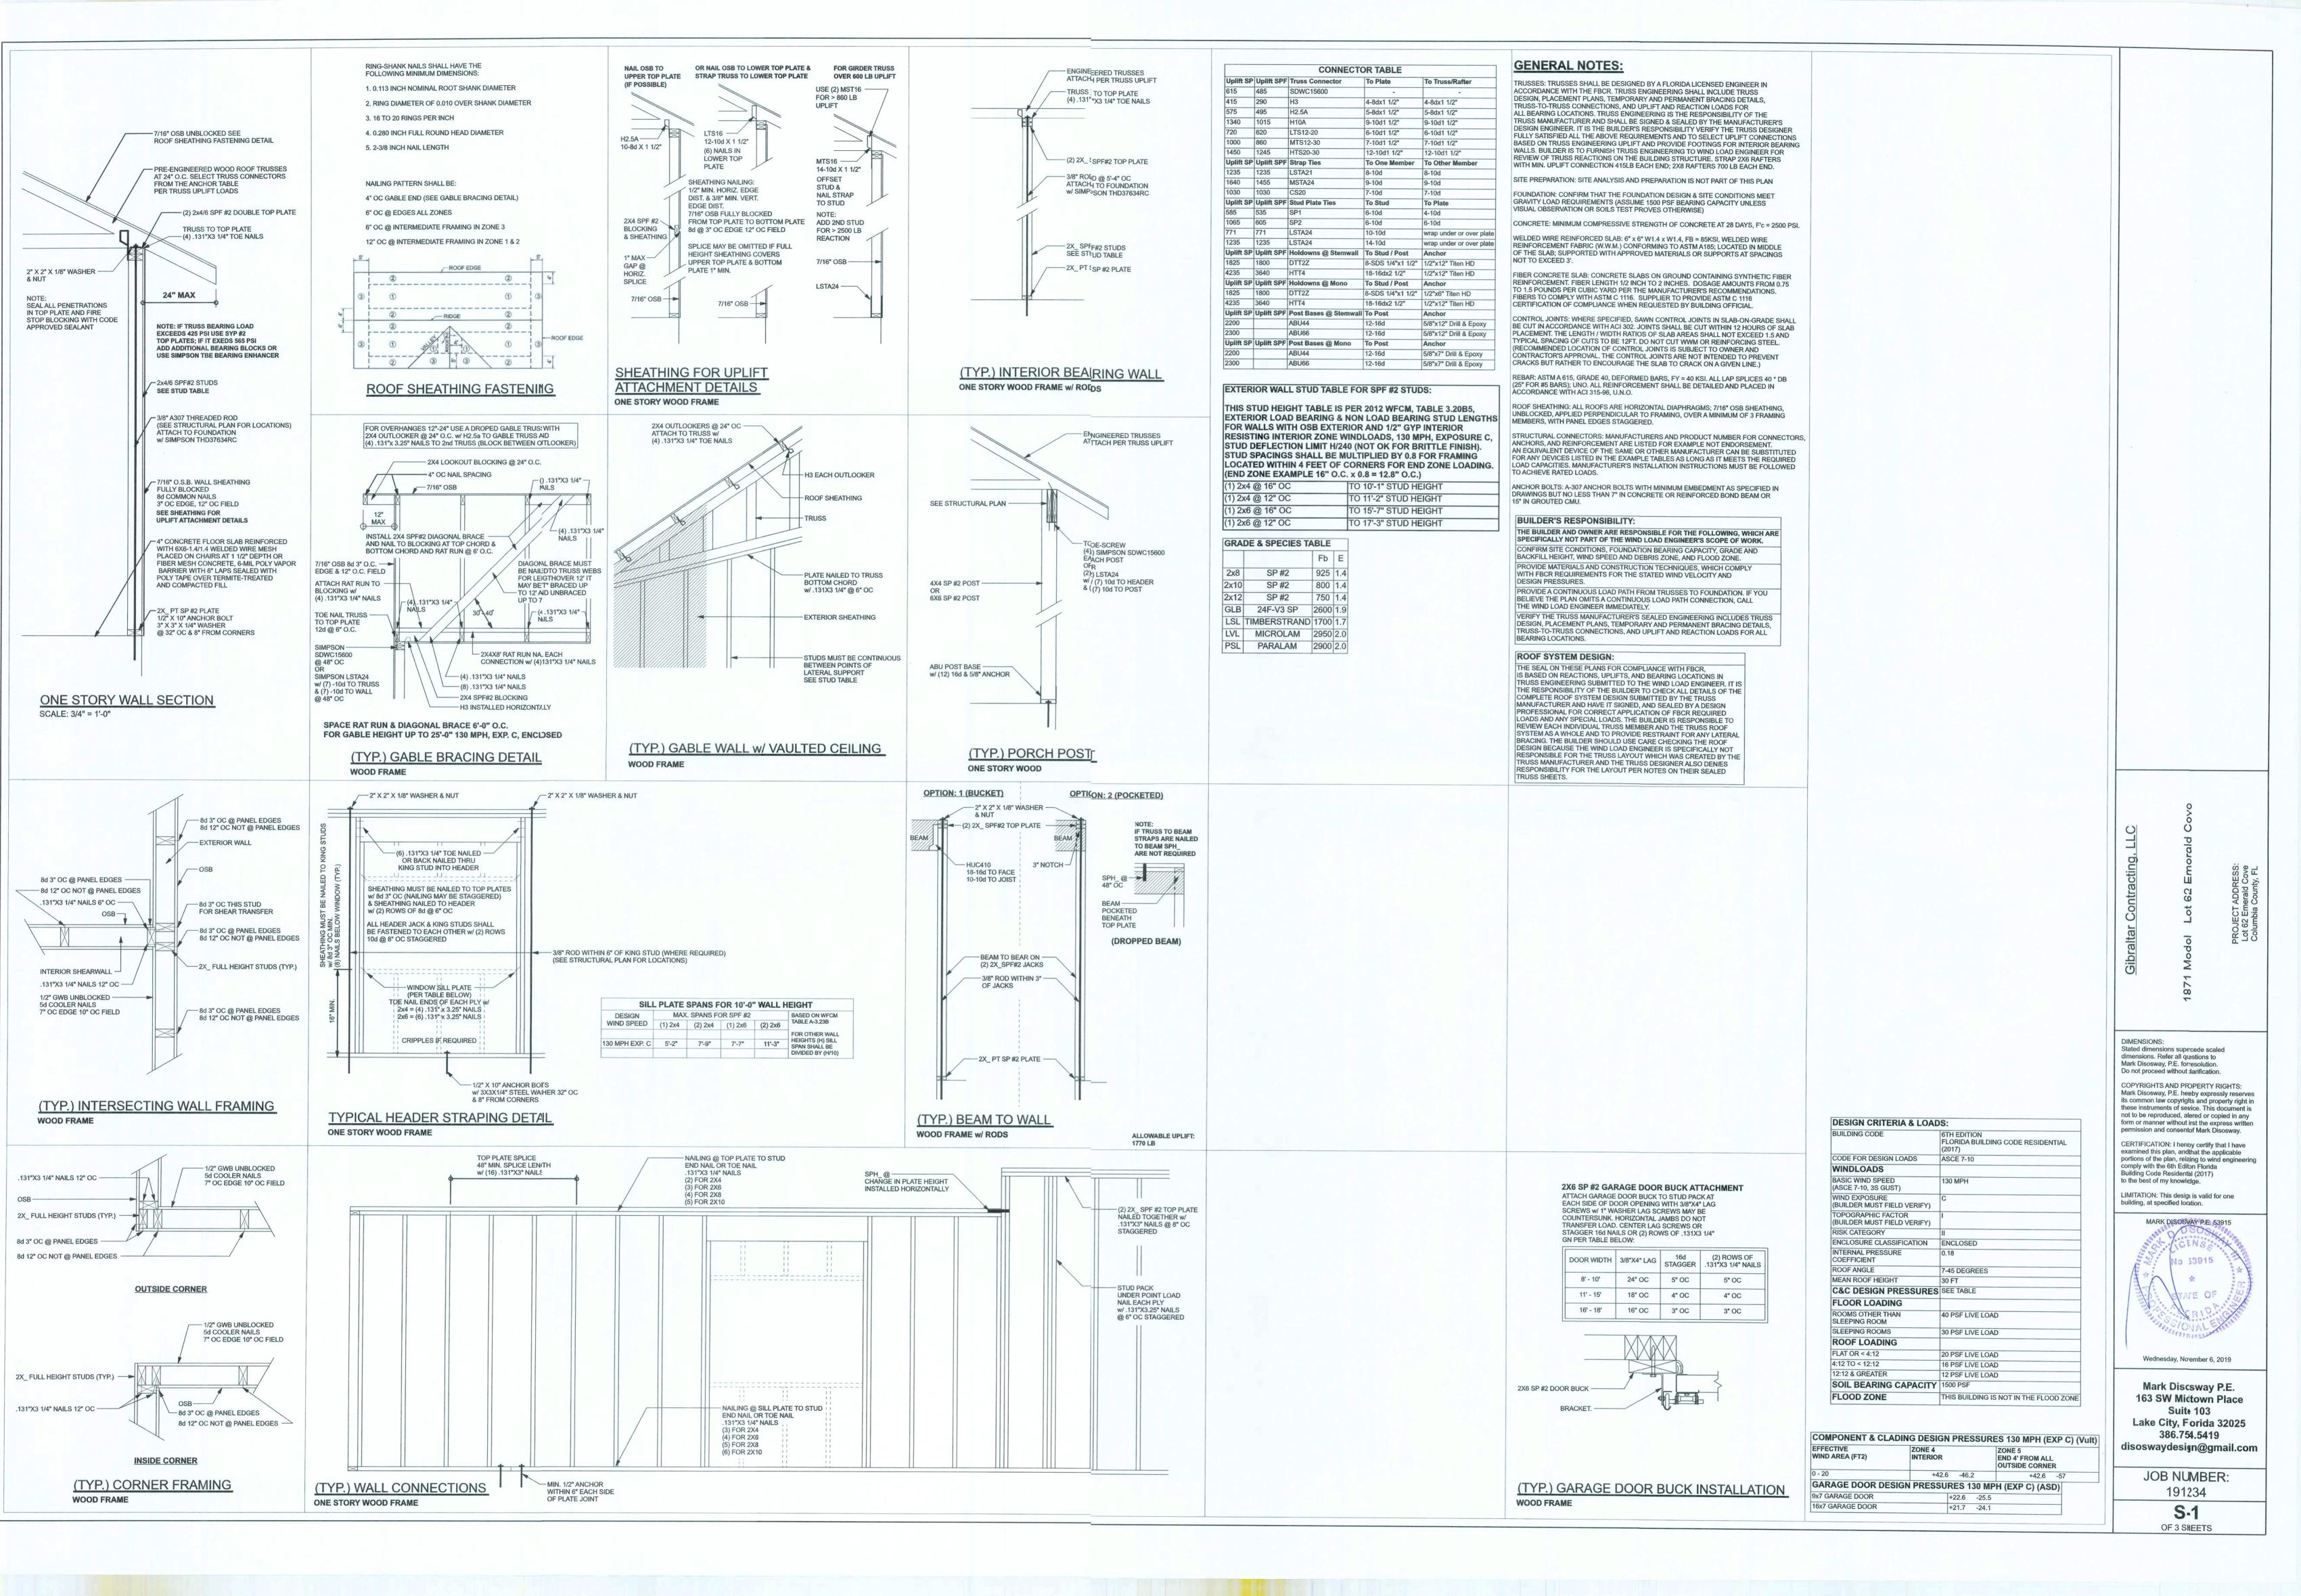

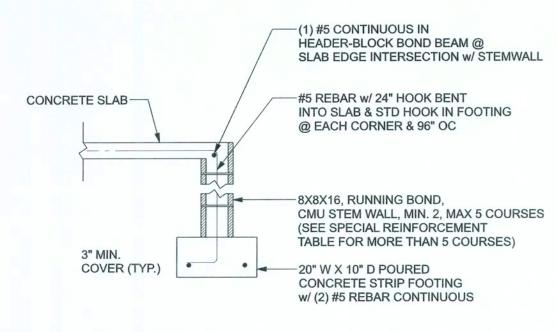


#### F1 OPTIONAL STEM WALL FOOTING


S-2 SCALE: 1/2" = 1'-0"

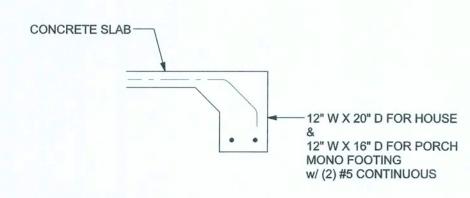


#### F1 MONOLITHIC FOOTING S-2 SCALE: 1/2" = 1'-0"

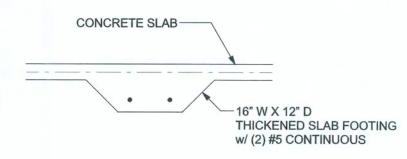


## F2 INTERIOR BEARING FOOTING S-2 SCALE: 1/2" = 1'-0"

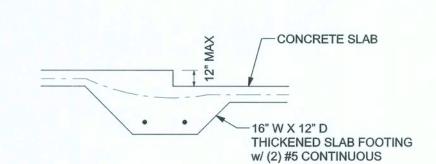

### F3 INTERIOR BEARING STEP FOOTING S-2 SCALE: 1/2" = 1'-0"

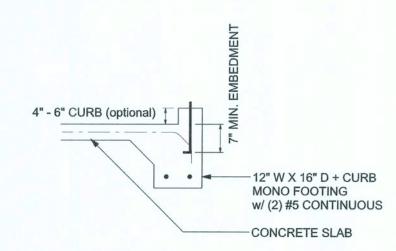

#### F4 MONOLITHIC CURB FOOTING S-2 SCALE: 1/2" = 1'-0"

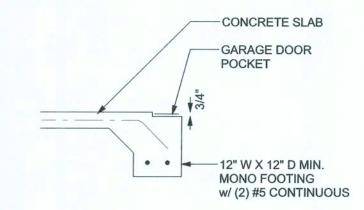


## F5 GARAGE DOOR POCKET FOOTING S-2 SCALE: 1/2" = 1'-0"

TILL STEM WALL TABLE:		
rinforced slab at the top. Th	inforcing bars with 6" hook in th se vertical steel is to be placed t	oward the tension side of the
isover 8' high, add Durowall	il pressure, within 2" of the exte ladder reinforcement at 16"OC	vertically or a horizontal bond
bam with 1#5 continuous at wth reinforcement as shown		the wall 12" CMU may be used
CELULATION TO THE PART AND THE	VEDTICAL DENIEGDOFMENT	THE TIOM DEINE ODOEMENT


TEMWALL HEIGHT (FEET)	UNBALANCED BACKFILL HEIGHT	VERTICAL REINFORCEMENT FOR 8" CMU STEMWALL (INCHES O.C.)		FOR 8" CMU STEMWALL FOR 12" CMU STEMWAL			
		#5	#7	#8	#5	#7	#8
3.3	3.0	96	96	96	96	96	96
4.0	3.7	96	96	96	96	96	96
4.7	4.3	88	96	96	96	96	96
5.3	5.0	56	96	96	96	96	96
6.0	5.7	40	80	96	80	96	96
6.7	6.3	32	56	80	56	96	96
7.3	7.0	24	40	56	40	80	96
8.0	7.7	16	32	48	32	64	80
8.7	8.3	8	24	32	24	48	64
9.3	9.0	8	16	24	16	40	48

NASO		D MATERIALS FOR THIS PROJECT DIREMENTS OF "SPECIFICATION
FOR M THE C PROC EETW ANY E	MASONRY STRUCTURES" CONTRACTOR AND MASON EEDING, NOTIFY THE ENC EEN ACI 530.1-02 AND TH	(ACI 530.1/ASCE 6/TMS 602). N MUST IMMEDIATELY, BEFORE GINEER OF ANY CONFLICTS
	ACI530.1-02 Section	Specific Requirements
1‡A	Compressive strength	8" block bearing walls F'm = 1500 psi
21	Mortar	ASTM C 270, Type N, UNO
22	Grout	ASTM C 476, admixtures require approval
23	CMU standard	ASTM C 90-02, Normal weight, Hollow, medium surface finish, 8"x8"x16" running bond and 12"x12" or 16"x16" column block
23	Clay brick standard	ASTM C 216-02, Grade SW, Type FBS, 5.5"x2.75"x11.5"
21	Reinforcing bars, #3 - #11	ASTM 615, Grade 40, Fy = 40 ksi, Lap splices min 40 bar dia. (25" for #5)
21F	Coating for corrosion protection	Anchors, sheet metal ties completely embedded in mortar or grout, ASTM A525, Class G60, 0.60 oz/ft2 or 304SS
2IF	Coating for corrosion protection	Joint reinforcement in walls exposed to moisture or wire ties, anchors, sheet metal ties not completely embedded in mortar or grout, ASTM A153, Class B2, 1.50 oz/ft2 or 304SS
33.E.2	Pipes, conduits, and accessories	Any not shown on the project drawings require engineering approval.
33.E.7	Movement joints	Contractor assumes responsibility for type and location of movement joints if not detailed on project drawings.

BOTTOM OF EXTERIOR FOOTINGS SHALL BE A MINIMUM OF
12" BELOW UNDISTURBED SOIL OR ENGINEERED FILL PER FBC 2014-RES. SECTION R403.1.4

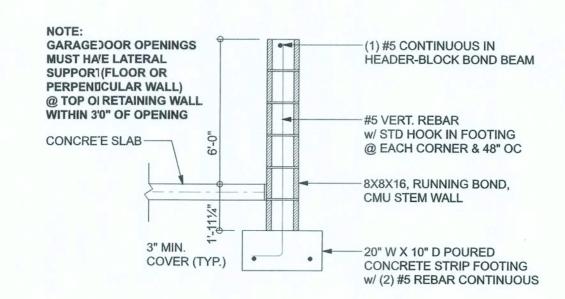

## F4 OPTIONAL STEM WALL CURB FOOTING S-2 SCALE: 1/2" = 1'-0"

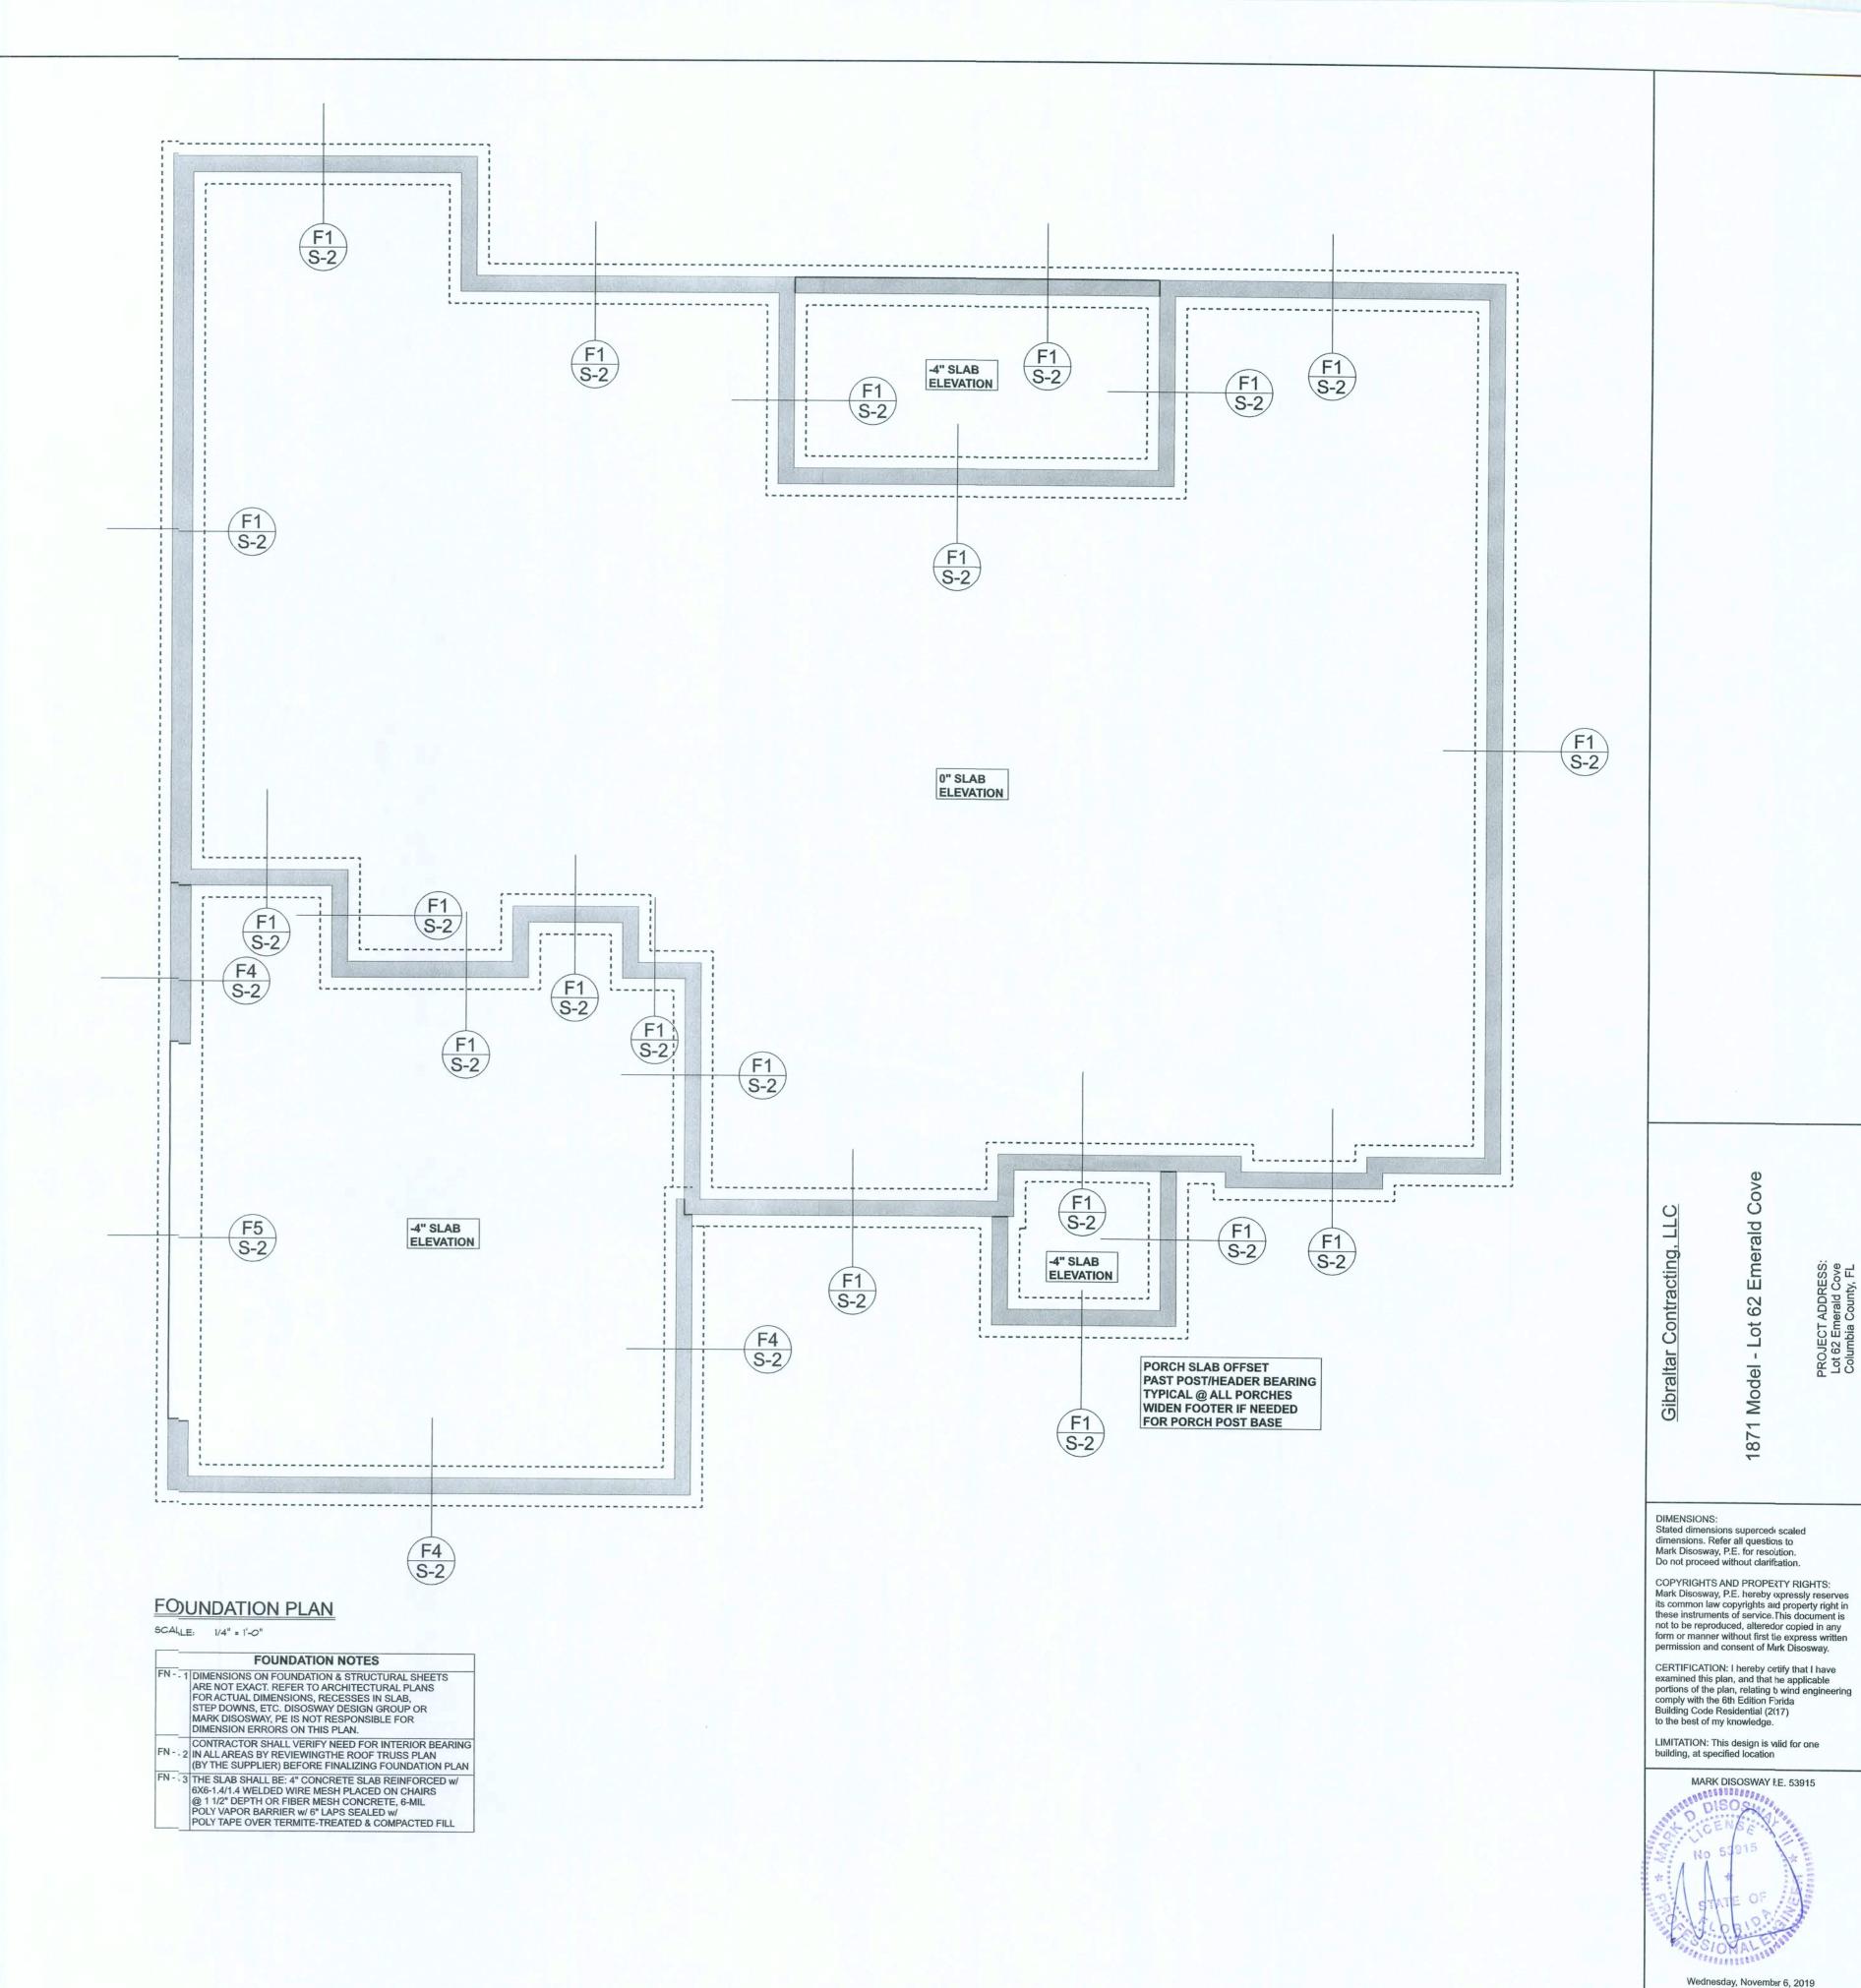


Mark Disosway P.E.

163 SW Midtown Place Suite 103 Lake City, Florida 32025 386.754.5419 disoswaydesign@gmail.com

JOB NUMBER: 191234

S-2 OF 3 SHEETS

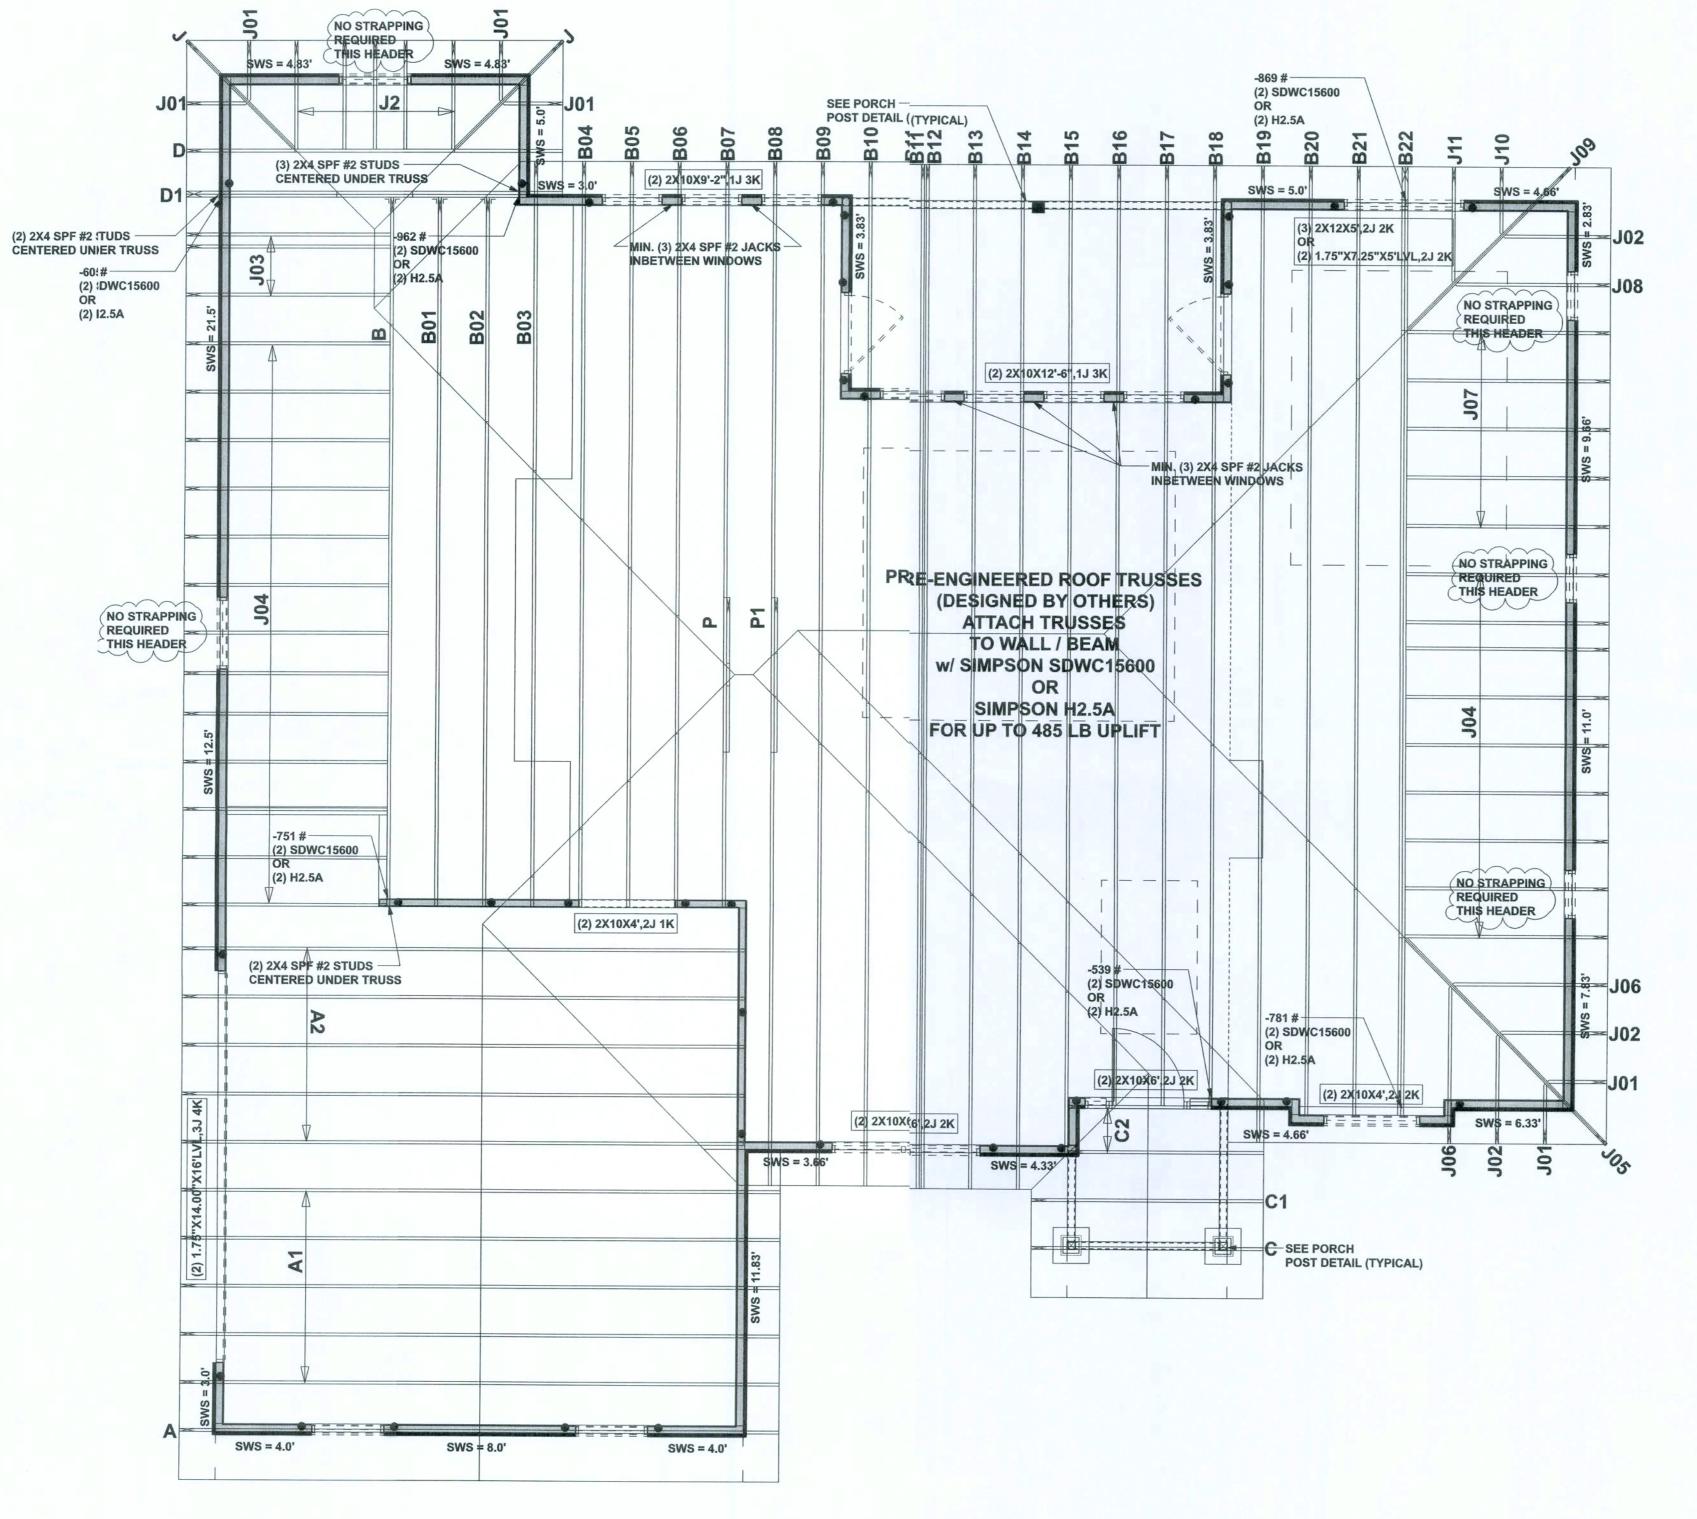

#### STRUCTURAL PLAN NOTES

SN-1 ALL LOAD BEARING FRAME WALL & PORCH HEADERS SHALL BE A MINIMUM OF (2) 2X10 SP #2 (U.N.O.)

SN-2 ALL LOAD BEARING FRAME WALL HEADERS SHALL HAVE (1) JACK STUD & (1) KING STUD EACH SIDE (U.N.O.)

SN-3 USE ONE JACK STUD GIRDER SUPPORT PER 2500 LB LOAD


SN-4 DIMENSIONS ON STRUCTURAL SHEETS
ARE NOT EXACT. REFER TO ARCHITECTURAL
FLOOR PLAN FOR ACTUAL DIMENSIONS

SN-5

PERMANENT TRUSS BRACING IS TO BE INSTALLED AT LOCATIONS AS SHOWN ON THE SEALED TRUSS DRAWINGS.

LATERAL BRACING IS TO BE RESTRAINED PER BCSI1-03, BCSI-B1, BCSI-B2, & BCSI-B3. BCSI-B1, BCSI-B2, & BCSI-B3 ARE FURNISHED BY THE TRUSS SUPPLIER, WITH THE SEALED TRUSS PACKAGE

#### HEADER LEGEND

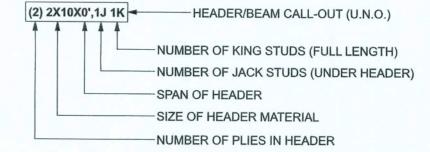

#### THREADED ROD LEGEND

REQUIRED 15031 LBF



# ACTUAL vs REQUIRED SHEARWALL TRANSVERSE LONGITUDUNAL ACTUAL 26174 LBF 14190 LBF

12593 LBF

1871 Model -

DIMENSIONS:
Stated dimensions supercedescaled dimensions. Refer all questions to Mark Disosway, P.E. for resolution. Do not proceed without clarification.

COPYRIGHTS AND PROPERTY RICE.

COPYRIGHTS AND PROPERTY RIGHTS:
Mark Disosway, P.E. hereby expressly reserves
its common law copyrights and property right in
these instruments of service. This document is
not to be reproduced, altered α copied in any
form or manner without first the express written
permission and consent of Mak Disosway.

CERTIFICATION: I hereby cerify that I have examined this plan, and that the applicable portions of the plan, relating towind engineering comply with the 6th Edition Floida Building Code Residential (207) to the best of my knowledge.

LIMITATION: This design is vaid for one building, at specified location.

MARK DISOSWAY DE 52045



Wednesday, Novembe 6, 2019

Mark Disosway P.E. 163 SW Midtown Place Suite 103 Lake City, Florida 32025 386.754.5419 disoswaydesign@gmail.com

JOB NUMBER: 191234

CONNECTIONS, WALL, & HEADER DESIGN IS BASED ON REACTIONS & UPLIFTS FROM TRUSS ENGINEERING FURNISHED BY BUILDER. W.B. HOWLAND TRUSS CO.

JOB #19-3047

**S-3**OF 3 SHEETS

STRUCTURAL PLAN
SCALE: 1/4" = 1'-0"