

SOFTPLAN

DIMENSIONED FLOOR PLAN

CROSSWINDS RUILTT OMITHEY 46,

LOT @ WM DEJGNE ASSOCIATES.NC.

SW COMMERCE DRSTI LAKE CITY, FL 3205 (386) 758-84(6 willingwillingers.ne

AREA SUMMARY

LIVING AREA 1,676 S.F. 136 S.F. 160 S.F. ENTRY PORCH AREA COVERED PORCH AREA GARAGE AREA 516 S.F. TOTAL AREA 2,488 S.F.

JOB NUMBER 20220822

SHEET NUMBER A.2

NOTE: ALL DRAWINGS NOT TO BE SCALED, WRITTEN DIMEMENSIONS TAKE PRECEDENCE OVER SCALED DIMENSIONS

2. Ducts in a private garage and ducts penetrating the walls or ceillings separating dwelling unit from the garage shall be constructed of a minimum 0.019-inch (0.48  $\rm f$  sheet steel and shall have no openings into the garage.

When installing an attic access and/or pull-down stair unit in the garage, devisell have a minimum 20 min. fire rating.

A separation is not required between a Group R-3 and U carport provided the cort is entirely open on two or more sides and there are not enclosed areas above.




NOTE:
ALL NITERIOR RECEPTACLES SHALLAFC!
ALL NITERIOR RECEPTACLES SHALLAFC!
(ARC PAULT CIRCUIT INTERRUPT) PEC 210.12 & TAMPER RESISTANT PER
NEC 408.11 ALL INTERIOR & EXTERIOR LIGHTIN/ALL MEET OR EXCEED THE MIN. 75% HIGH-EFFICIENCY LIGHTING PER FBC-ENERGY CONSETION R404.

ALL SMOKE DETECTORS BE A COMMINKE & CARBON MONOXIDE DETECTOR AND SHALL HAVE BATTERY BACKUPTER AND ALL WRED TOGETHER SO IF ANE UNIT IS ACTUATED THEY ALL ACTIVATE.

THE ELECTRICAL SERVICE OVERCUNT PROTECTION DEVICE SHALL BE INSTALLED ON THE EXTERIOR OF STITURES TO SERVE AS A DISCONNECT MEANS. CONDUCTIONS USED FROM THE STYR DISCONNECTION MEANS TO A PANEL OR SUB-PANEL SHALL HAVE FOLIA-WIRE OD/TORS, OF WHICH ONE CONDUCTOR SHALL HAVE FOLIA-WIRE OD/TORS, OF WHICH ONE CONDUCTOR SHALL BY THE OWNER OF THE OWNER OF THE OWNER OWN

IT IS THE LICENSED ELECTRICAL COACTORS RESPONSIBILITY TO INSURE THAT ALL WORK PERFORMED AND EQUIPMENTALLED METS OR EXCEEDS THE 2017 (NFPA-70) NATIONAL ELECTRIC CODE AND ALL OTHER LOCODES AND ORDINANCES.

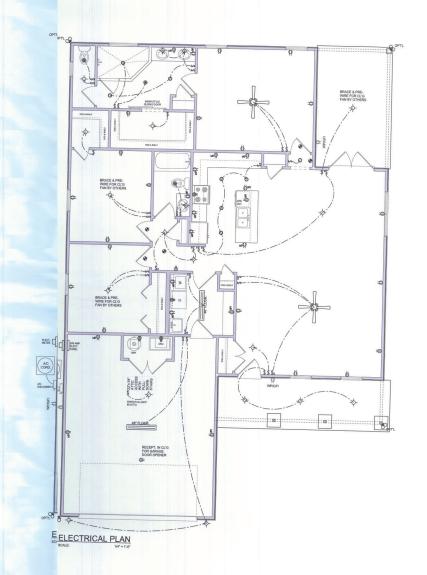

SOFTPIAN

ELECTRICAL PLAN

1676 FOR:

"46, CROSSWINDS
ADDRESS: COLUMBIA COUNTY, FLORIDA

MODEL 1676 FOR:
LOT 46, CROSS
PROJECT ADDRESS: COLUMBIA COUNTY,
RHETT SMITHEY
LAWECITY, RORGIA

© WM DE-SIGN &
A 5-50/CATE-5, NC.
425 SW COMMERCE DR. STE 130
LAKE CITY, FL. 32025
(386) 758-8406
willigwillingers net





20220822

SHEET NUMBER A.3

Dul C-977

NOTE: ALL DRAWINGS NOT TO BE SCALED, WRITTEN DIMENSI SIONS TAKE PRECEDENCE OVER SCALED DIMENSIONS

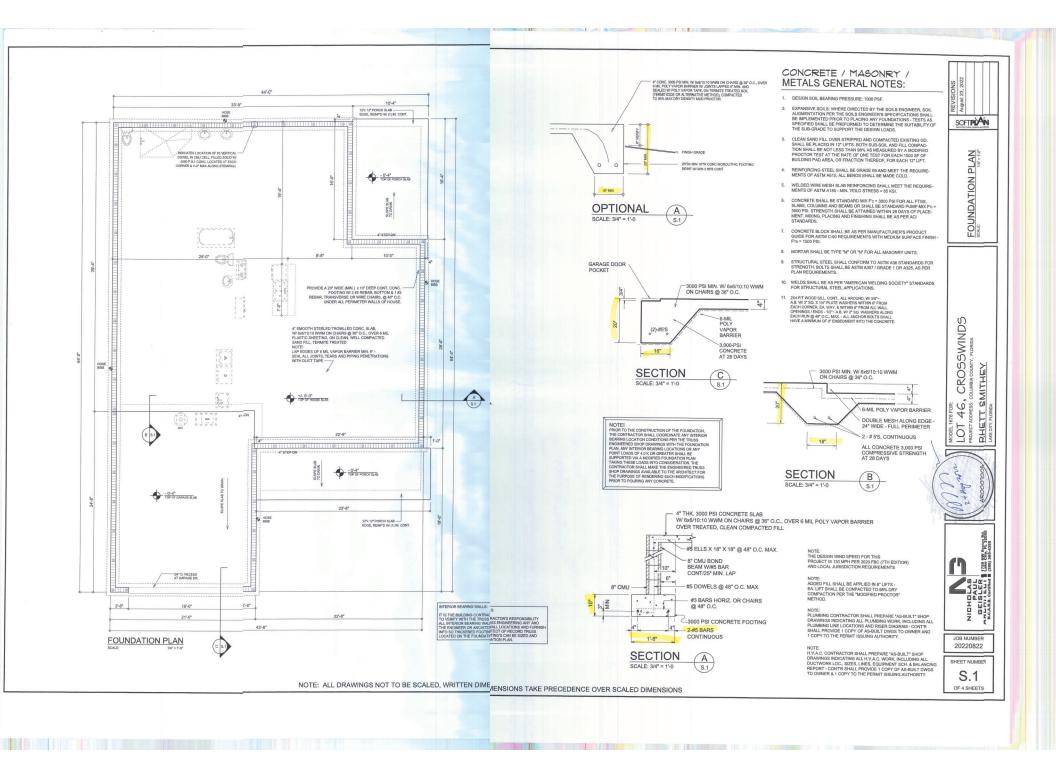

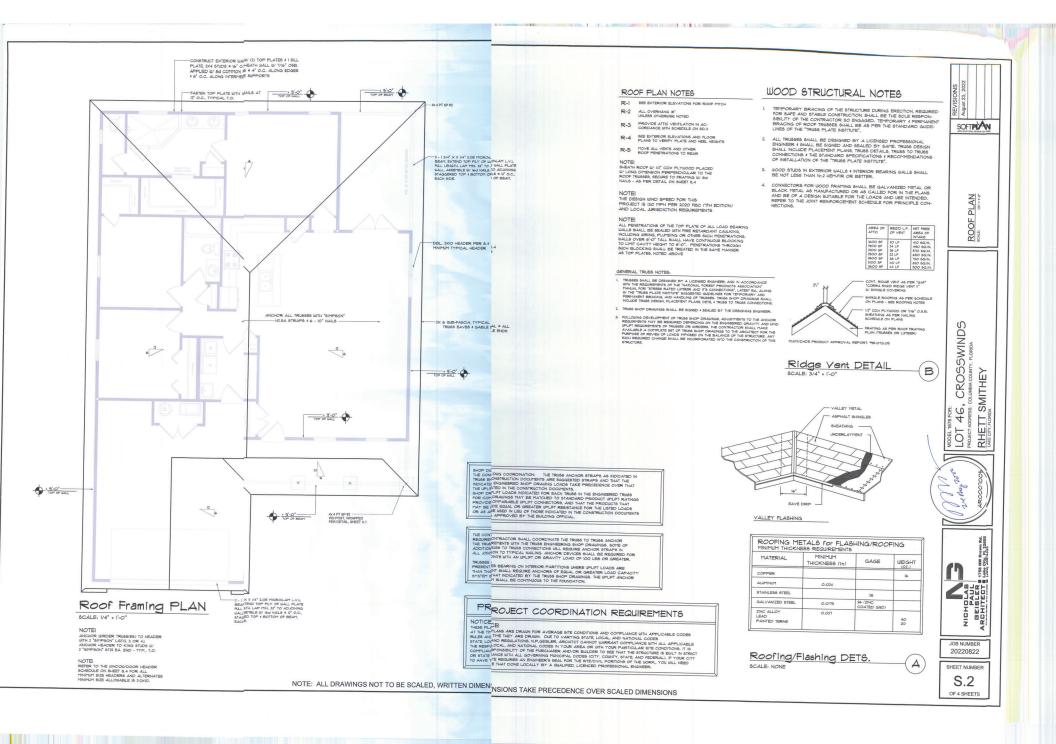

#### TERMITE PROTECTION NOTES:

SOIL CHEMICAL BARRIER METHOD:

3. IRRIGATION/SPRINKLER SYSTEMS INCLUDING ALL RISERS AND SPRAY HEADS SHALL NOT BE INSTALLED WITHIN 1-0\* FROM BUILDING SIDE WALLS, FBC 1503.4.4

4. TO PROVIDE FOR INSPECTION FOR TERMITE INFESTATION, BETWEEN WALL COVERINGS AND FINAL EARTH GRADE SHALL NOT BE LESS THAN 6° EXCEPTION: PAINT AND DECORATIVE CEMENTIOUS FINISH LESS THAN 5/6" THICK ADHERED DIRECTLY TO THE FOUNDATION WALL. FBC 1403.1.6

5. INITIAL TREATMENT SHALL BE DONE AFTER ALL EXCAVATION AND BACKFILL IS COMPLETE. FBC 1816.1.1

6. SOIL DISTURBED AFTER THE INITIAL TREATMENT SHALL BE RETREATED INCLUDING SPACES BOXED OR FORMED. FBC 1816.1.2

7. BOXED AREAS IN CONCRETE FLOOR FOR SUBSCULENT INSTALLATION OF TRAPS, ETC., SHALL BE MADE WITH PERMANENT METAL OR FLASTIC FORMS, PERMANENT FORMS MUST BE OF A SIZE AND DEPTH THAT WILL ELIMINATE THE DISTURBANCE OF SOIL AFTER THE INITIAL TREATMENT. FBG 1916.13.

ELIMINATE THE DISTURBANCE OF SOL AFTEN THE NUML. THEATMENT, THE STREET OF HOTELET OF STREET AND ATTENDED TO PROTECT OF STREET, AND ATTENDED TO PROTECT OF STREET, AND ATTENDED THE STREET, AND AND ASSOCIATION AND ASSOCIATION AND ASSOCIATION AND ASSOCIATION AND ASSOCIATION AND ASSOCIATION ASSOCIATI

12. ALL BUILDINGS ARE REQUIRED TO HAVE PER-CONSTRUCTION TREATMENT. FBC 1816.1.7

FBC 1891.3 A CERTIFICATE OF COMPLANCE MUST BE ISSUED TO THE BUILDING DEPARTMENT BY SUCCESSED FROM TO COMPANY BEFORE A CERTIFICATE OF CONCUMENT WILL BE SIMED. THE CERTIFICATE OF COMPLANCE SMALL BE SIMED. THE CERTIFICATE OF COMPLANCE SMALL BE SIMED THE CERTIFICATE OF COMPLANCE SMALL BETWEEN THE BUILDING HAS RECEIVED A COMPLETE THEATMENT FOR THE PREVAIL BY THE SHEET BY THE

UNIEN GENTYLES, FOU TOURLETED, LOOSE WOOD AND FILL MUST BE REMOVED FROM BELOW AND WITHIN 1:0" OF THE BUILDING, THIS BICLUDES ALL GRADE STAKES, TUB TRAP BOXES, FORMS, SHORING OR OTHER CELLULOSE CONTAINING MATERIAL, FBC 22021.3

15. NO WOOD, VEGETATION, STUMPS, CARDBOARD, TRASH, ETC., SHALL BE BURIED WITHIN 15-0° OF ANY BUILDING OR PROPOSED BUILDING. FBC 2303.1.4

### FRAMING ANCHOR SCHEDULE


MANUF'R/MODEL IMPSON H2.54 (OR EQUIVALENT), W 6 - 10d NAIL SIMPSON LGT, W 28 - 16d NAILS SIMPSON ST22 SIMPSON SP2 SIMPSON SP2 TRUSS TO WALL GIRDER TRUSS TO POST/HEADER: HEADER TO KING STUD(S): PLATE TO STUD: STUD TO SILL: PORCH BEAM TO POST: PORCH POST TO FND.: MISC. JOINTS SIMPSON PC44/EPC44 SIMPSON ABU44 SIMPSON A34

NOTE:
ALL ANCHORS SHALL BE SECURED W NAILS AS PRESCRIBED BY THE
MANUFACTURER FOR MAXIMUM JOINT STRENGTH, UNLESS NOTED OTHERWISE.

REFER TO THE INCLUDED STRUCTURAL DETAILS FOR ADDITIONAL ANCHORS/ JOINT REINFORCEMENT AND FASTENERS.

NOTE:
ALL UNLISTED JOINTS IN THE LOAD PATH SHALL BE REINFORCED WITH SIMPSON A34 FRAMING ANCHORS, TYPICAL T.O. NOTE:
"SEMCO" PRODUCT APPROVAL:
MIAMI/DADE COUNTY REPORT #95-0818.15

MIAMILIPAGE COORT.
NOTE:
"SIMPSON" PRODUCT APPROVALS:
MIAMICADE COUNTY REPORT #97-0107.05, #96-1126.11, #99-0623.04
SBCC1 NER-443, NER-383

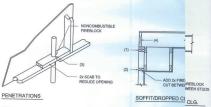

FIREBLOCKING NOTES:

FIREBLOCKING SHALL BE INSTALLED IN WOOD FRAME CONSTRUCTION IN THE FOLLOWING LOCATIONS:

- IN CONCEALED SPACES OF STUD WALLS AND PARTITIONS INCLUDING FURRED SPACES AT CEILING AND FLOOR LEVELS.
- AT ALL INTERCONNECTIONS BETWEEN CONCEALED VERTICAL AND HORIZONTAL SPACES SUCH AS OCCUR AT SOFFITS, DROP CEILINGS, COVE CEILINGS, ETC.
- AT OPENINGS AROUND VENTS, PIPES, DUCTS, CHIMNEYS AND FIREPLACES AT CEILING AND FLOOR LEVELS WITH "PYROPANEL MULTIFLEX SEALANT"
- AT ALL INTERCONNECTIONS BETWEEN CONCEALED VERTICAL STUD WALL OR PARTITION SPACES AND CONCEALED SPACES CREATED BY AN ASSEMBLY OF FLOOR JOISTS, FREED GOKING SHALL BE PROVIDED FOR THE FULL DEPTH OF THE JOISTS AT THE ENDS AND OVER THE SUPPORTS.

Fire Stopping DETAILS

SCALE: NONE



4			" MEAN BU	COMPONENT ILDING HEIGH IGLE 2T TO 4	T = 30,0' EX	IG LOADS POSURE "B
	ZONE	AREA	No Well	Vult 120 MPH	Vult ISO MPH	Vult 140 MPH
49	1	10 20 80	19.9 / -2L8 19.4 / -2O.7 18.6 / -19.2	23.7 / -25.9 23.0 / -24.6 22.2 / -22.8	21.8 / -30.4 21.0 / -28.9 26.0 / -26.8	32.3 / -35.3 31.4 / -33.5 30.2 / -31.1
A 21 TO	2 2 2	10 20 50	19.9 / -25.5 19.4 / -24.3 18.6 / -22.9	23.7 / -30.3 23.0 / -29.0 22.2 / -27.2	21.8 / -35.6 21.0 / -34.0 26.0 / -32.0	32.3 / -41.2 31.4 / -39.4 30.2 / -37.1
Tank.	3 3	10 20 50	19.9 / -25.5 19.4 / -24.3 18.6 / -22.9	23.7 / -30.3 23.0 / -29.0 22.2 / -27.2	21.8 / -35.6 21.0 / -34.0 26.0 / -32.0	32.3 / -41.2 31.4 / -39.4 30.2 / -37.1
- 1	4 4 4	10 20 80	21.8 / -23.6 20.8 / -22.6 19.5 / -21.3	25.9 / -34.7 24.7 / -26.9 23.2 / -25.4	30.4 / -33.0 29.0 / -31.6 21.2 / -29.8	35.3 / -38.2 33.7 / -36.7 31.6 / -34.6
	5 5 5	10 20 80	21.8 / -29.1 20.8 / -21.2 19.5 / -24.6	25.9 / -34.7 24.7 / -32.4 23.2 / -29.3	30.4 /-40.7 28.0 / -38.0 21.2 / -34.3	35.3 / -47.2 33.7 / -44.0 31.6 / -39.8

HEIGHT A	EXPOSURE ALL LDING COMPO	DJUSTMENT CO	DING
BLDG HEIGHT	EXPOSURE "B"	EXPOSURE "C"	EXPOSURE
15 20 25 30	L00 L00 L00 L00	1.21 1.29 1.35 1.40	L47 L88 L61

General Roofing NOTES:

DECK REQUIREMENTS: ASPHALT SHINGLES SHALL BE FASTENED TO SOLIDLY SHEATHED DECKS.

ASPHALT SHINGLES SHALL BE USED ONLY ON ROOF SLOPES OF 2:12 OR GREATER. FOR ROOF SLOPES FROM 2:12 TO 4:12, DBL. UNDERLAYMENT IS REQUIRED.

UNLESS OTHERWISE NOTED, UNDERLAYMENT SHALL CONFORM W/ ASTM D 226, TYPE 1, OR ASTM D 4869, TYPE 1.

FOR ROOF SLOPED 4:12 AND OREATER, UNDERLAYMENT SMALL BE A MINIMUM OF ONE LAYER OF UNDERLAYMENT FELT APPLIED AS FOLLOWS: STARTING AT THE EAVE, UNDERLAYMENT SMALL BE APPLIED SHINGLE PASHON PARALLEL TO THE EAVE, LAPPED 2 INCHES, AND FASTENED SHIPCIDENTLY OSTAY IN PLACE.

BASE AND CAP FLASHINGS:
BASE AND CAP FLASHINGS:
BASE AND CAP FLASHING SHALL BE INSTALLED IN ACCORDANCE WITMFGR'S
BASE AND CAP FLASHING SHALL BE OF ETIMER CORPOSION
BASE FLASHING SHALL BE OF THE OFFICE OF THE OFFICE OFFI
BASE FLASHING SHALL BE OFFICE OFFI
BASE FLASHING SHALL BE OFFI
BASE FLASH

ROOFSHINGLES SHALL BE AS MANUFACTURED BY "TAMKO ROOFING PRODUCTS" OF THE FOLLOWING MODELS: GLASS-SEAL AR ELITE GLASS-SEAL AR HERITAGE 30 AR HERITAGE 40 AR HERITAGE 50 AR

THESE SHINGLES MEET THE REQUIREMENTS OF ASTM D-3161 TYPE 1 MODIFIED TO 110 MPH WINDS & FBC TAS 100, USING 4 NAILS/SHINGLE

UNDERLAYMENT

SELF-ADHERING POLYMER MODIFIED BITUMEN SHEET: SELF ADHERING POLYMER MODIFIED BITUMEN SHALL COMPLY W/ ASTM D 1970.

ASPHALT SHINGLES: ASPHALT SHINGLES SHALL HAVE SELF SEAL STRIPS OR BE INTERLOCKING, AND COMPLY WITH ASTM D 22S OR ASTM D 3462.

PASTEMERS FOR ASSINAL THRICLES SMALL BE GALVANCED, STAINLESS FASTEMERS FOR ASSINAL THRICLES SMALL BE GALVANCED, STAINLESS FASTEMENT OF A GALVE BANK WITH A MINIMAL 38 INFO DIAMETER FACTOR THRICLES FOR THE ROOF BIRSTNING. WHICH ROOF BIRSTNING, AND A BINNIMAL 35 IN FOR THE ROOF BIRSTNING. WHICH ROOF BIRSTNING SEEDS THAN 34" THICK, THE RALL SMALL PRETTATE THROUGHT THE GREATMENT BE LIEST THAN 34" THICK, THE RALL SMALL PRETTATE THROUGHT THE GREATMENT.

ATTACHMENT:
APPLICATION OF THE ROOF WITH NOT LESS THAN APPLICATION OF THE ROOF WITH NOT LESS THAN APPLICATION OF THE SHINGLE OR TWO FASTENERS FER ROOTIVALATION OF THE ROOT OF THE ROOTIVAL OF THE ROOTIVAL WITHOUT OF THE ROOTIVAL METHODS OF A PATENDING AND ESPECIAL FOR THE ROOTIVAL METHODS OF A PATENDING AND ESPECIAL THINGLES SHALL COMPORTIVATION OF A SPHALT SHINGLES SHALL COMPORTIVATION OF THE ROOTIVAL OF THE RO

UNDERLAYMENT APPLICATION:
FOR ROOF STORM 212 TO 412, UNDERLAYMENT SHALL BE A MINIMUM
OF TWO, LAYOPES FORM 212 TO 412, UNDERLAYMENT SHALL BE A MINIMUM
OF TWO, LAYOPES FORM 212 TO 412, OF THE APPLICATION O

STARTING AT THE EAVE, 36 INCH WIDE STRIPS OF UNDERLAYMENT FELT SHALL BE APPLIED OVERLAPPING SUCCESSIVE SHEETS 19 INCHES AND FASTENED SUFFICIENTLY TO STAY IN PLACE.

NOMINAL TRICOMESS OF 0.019 BIOCI.

VALLEYS: WALLEY LINNED SHALLES IN ACCORDANCE W MARPETURENS.

VALLEY LINNED SHALLES IN STALLED IN ACCORDANCE W MARPETURENS.

STALLATION BATRICICTIONS BEFORE APPL WAS ASPINAL T SHINGLES. WALLEY
LEFT OF THE CALLOWING TYPES SHALL BE EPRATUTED.

LEFT OF THE CALLOWING TYPES SHALL BE EPRATUTED.

LEFT OF THE CALLOWING TYPES SHALL BE EPRATUTED.

AT LEAST 15 WINE AND OF ANY OF THE TWO VALLEY LINNED SHALL BE.

AT LEAST 15 WINE AND OF ANY OF THE OPT WAS LIPPACE.

AN EXCLUSIVE AND OF ANY OF THE OPT WAS LIPPACE.

AN EXCLUSIVE AND OF ANY OF THE OPT WAS LIPPACE.

AND LIPPACE AND OF ANY OF THE OPT WAS LIPPACE.

AND LIPPACE WAS LIPPACE.

AND LIPPACE WAS LIPPACE.

AND AND LIPPACE.

AND LIPPA

1758 NW Brown Rd. (386) 365-4355 -NICHOLAS GEISLER ARCARL Corting

SOFTPLAN

DETAILS SHEET

CROSSWIND

0

4 MODEL 167
LOT
PROJECT AD

2

**EMITHEY** 


JOB NUMBER 20220822

SHEET NUMBER S.3 OF 4 SHEETS

NOTE: ALL DRAWINGS NOT TO BE SCALED, WRITTEN DIMENSIONS TAKE PRECEDENCE OVER SCALED DIMENSIONS



GABLE END GYPSUM DIAPHRAGM HOLDOWN CONNECTOR

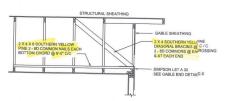


### **END WALL BRACING FOR CEILING DIAPHRAGM**

(ALTERNATIVE TO BALLOON FRAMING)

NOTE: ALL WOOD TO BE NUMBER 2 GRADE SOUTHERN YELLOW PINE

	ZONE	AREA	Vult 110 MPH	Vult 120 MPH	Vult 130 MPH	Vult 140 MPH
	1 1	10 20 50	12.0 / -19.9 11.4 / -19.4 10.0 / -18.6	14.9 / -23.7 13.6 / -23.0 11.9 / -22.2	17.5 / -27.8 16.0 / -27.0 13.9 / -26.0	20.3 / -32.3 18.5 / -31.4 16.1 / -30.2
F 7" TO 27"	2 2 2	10 20 50	12.5 / -34.7 11.4 / -31.9 10.0 / -28.2	14.9 / -41.3 13.6 / -38.0 11.9 / -33.6	17.5 / -48.4 16.0 / -44.6 13.9 / -39.4	20.3 / -56.2 18.5 / -51.7 16.1 / -45.7
ROOF	3 3 3	10 20 50	12.5 / -51.3 11.4 /-47.9 10.0 / -43.5	14.9 / -61.0 13.6 / -57.1 11.9 / -51.8	17.5 / -71.6 16.0 / -67.0 13.9 / -60.8	20.3 / -83.1 18.5 / -77.7 16.1 / -70.5
WALL	4 4 4	10 20 50	21.8 / -23.6 20.8 / -22.6 19.5 / -21.3	25.9 / -34.7 24.7 / -26.9 23.2 / -25.4	30.4 / -33.0 29.0 / -31.6 27.2 / -29.8	35.3 / -38.2 33.7 / -36.7 31.6 / -34.6
	5 5 5	10 20 50	21.8 / -29.1 20.8 / -27.2 19.5 / -24.6	25.9 / -34.7 24.7 / -32.4 23.2 / -29.3	30.4 /-40.7 29.0 / -38.0 27.2 / -34.3	35.3 / -47.2 33.7 / -44.0 31.6 / -39.8

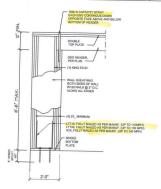


Garage End Wall DETAIL

SCALE: NTS

NAILING ZONE	SHEATHING TYPE	FASTENER	SPACING
1	7/16 * O.S.B. OR 15/32 CDX	Ar COMMON OR	6 in. o.c. EDGE 12 in. o.c. FIELD
2		8d HOT DIPPED GALVANIZED	6 in. a.c. EDGE 6 in. a.c. FIELD
3		BOX NAILS	4 in.o.c. @ GABLE ENDWAL OR GABLE TRUSS 6 in.o.c. EDGE 6 in.o.c. FIELD

HEIGHT 8 FOR BUIL	DING	XPOSURE ADJUSTMENT COEFFICIENTS NG COMPONENTS & CLADDING				
BLDG HEIGHT	- T	EXPOSURE "B"	EXPOSURE "C"	EXPOSURE "D"		
15 20	1	1.00	121	1.47		
25	1	1.00	1.29	1.55		


В

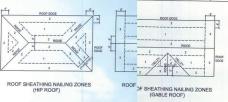


# Roof Nail Pattern DET.

SCALE: NONE

			E	BUILDING WID	TH (F		
HEADERS	HEADER SIZE		20'	28'			
SUPPORTING:		SPAN	#JACKS	SPAN #	JACK-		36'
	2-2x4	3'-6"	1	3'-2"	CKS	SPAN	#JACKS
	2-2x6	5'-5"	1	4'-8"	1	2'-10"	1
ROOF, CEILING	2-2x8	6'-10"	1	5'-11"	1	4'-2"	1
	2-2x10	8'-5"	2	7'-3"	2	5'-4"	1
	2-2x12	91-9"	2	8'-5"	2	6'-6"	2
	3-2x8	8'-4"	1	7'-5"	2	7'-6"	2
	3-2x10	10'-6"	- 1	9'-1"	1	6'-8"	1
	3-2x12	12'-2"	2	10'-7"	2	8'-2"	1
	4-2x8	9'-2"	4	8'-4"	2	9'-5"	2
	4-2x10				1	9'-2"	1
		11'-8"	1	10'-6"	1	9'-5"	- 1
	4-2x12	14'-1"	1	12'-2"	2 2	10'-11"	,

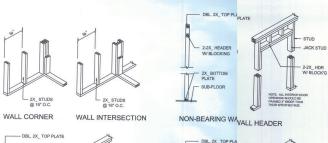


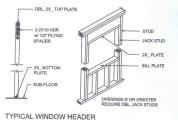

Г	- DBL 2X_TOP PLA	ATE /	
	- 2-2X10 HDR W/ 1/2* PLYWOOD SPACER		STUD
	- 2X_BOTTOM PLATE - SUB-FLOOR		2X_ PLATE  JACK STUD
BEAR	NG WALL HE	ADER	

## Wall Framing/Header DETAILS

NOTE: ALL DRAWINGS NOT TO BE SCALED, WRITTEN DIMENENSIONS TAKE PRECEDENCE OVER SCALED DIMENSIONS

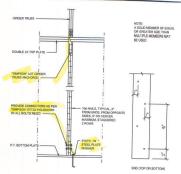

"WindSTORM" ALT. SHEATHING METHOD:

Alternate 'Titan' bolt concrete anchor system EANCHOR SILL PLATE WITH 58" TITAN ANCHOR BOLT, PLACED AT 40" O.C. AROUND PERMETER OF SLAB AND ALL INTERIOR BEARING WALLS, MAIN 4" FAMILTON

C

D

SOFTPLAN

DETAILS SHEET


CROSSWINDS

46,

101

RHETT SMITHEY

Girder Truss Column DET.

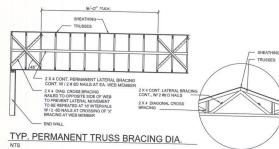

NOTE: ALL WOOD TO BE NUMBER 2 GRADE SOUTHERN YELLOW PINE

Truss Bracing DETAILS SCALE: AS NOTED

BLOCKING @ JOINTS IN SHEATHING EGDE OR FLAT P.T. BOT. PLAT

NAIL SPACING SHALL BE 4" O.C. EDGES AND 8" O.C. IN THE FIELD.

SILL PLATES

Shear Wall DETAILS

Е

NICHOL PA GEISL ADDHITE

(386) 365-4355

JOB NUMBER 20220822

SHEET NUMBER **S.4** OF 4 SHEETS